

# PAVEMENT NOTES

FULL DEPTH HOT MIX ASPHALT SHARED USE PATH

SURFACE COURSE: 1-3/4" SUPERPAVE SURFACE COURSE - 9.5 (SSC-9.5) OVER

2-1/4" SUPERPAVE INTERMEDIATE COURSE - 19.0 (SIC-19.0) OVER INTERMEDIATE COURSE:

FOUNDATION: 2" - 8" GRAVEL BORROW (M1.03.0 TYPE B) (SEE NOTE BELOW) OVER

SPECIAL BORROW AS REQUIRED (SEE NOTE BELOW)

NOTE: SUBBASE SHALL BE A MINIMUM OF 2" GRAVEL BORROW FOR LEVELING OVER RAILROAD BALLAST. SUBBASE SHALL BE 8" GRAVEL BORROW OVER SPECIAL BORROW AT FILL SECTIONS IN AREAS OF WETLANDS AND OTHER UNSUITABLE MATERIAL IN ACCORDANCE WITH SECTION 150 AND 170 OF THE STANDARD SPECIFICATIONS FOR HIGHWAYS AND BRIDGES.

#### PAVED SHARED USE PATH OVER BRIDGES (OVER THE NASHOBA BROOK, SEE BRIDGE PLANS FOR DETAILS)

1-3/4" SUPERPAVE SURFACE COURSE - 9.5 (SSC-9.5) OVER SURFACE COURSE:

**INTERMEDIATE COURSE:** 2-1/4" SUPERPAVE INTERMEDIATE COURSE - 19.0 (SIC-19.0) OVER

FOUNDATION: VARIABLE DEPTH CRUSHED STONE (M2.01.1) OVER

2" SAND OVER

MEMBRANE WATERPROOFING OVER EXISTING 8" REINFORCED CONCRETE DECK

3" SUPERPAVE INTERMEDIATE COURSE - 19.0 (SIC-19.0) OVER

#### FULL DEPTH HOT MIX ASPHALT CONSTRUCTION (AT ROADWAY CROSSINGS & MAIN ST. AND COMM. AVE.)

SURFACE COURSE: 1-3/4" SUPERPAVE SURFACE COURSE - 9.5 (SSC-9.5) OVER 1-3/4" SUPERPAVE SURFACE COURSE - 9.5 (SSC-9.5) OVER

3" SUPERPAVE INTERMEDIATE COURSE - 19.0 (SIC-19.0) OVER INTERMEDIATE COURSE:

4" DENSE GRADED CRUSHED STONE FOR SUB-BASE OVER SUBBASE:

8" GRAVEL BORROW (M1.03.0 TYPE B)

#### FULL DEPTH WIDENING LESS THAN 4 FEET

SURFACE COURSE: 1-3/4" SUPERPAVE SURFACE COURSE - 9.5 (SSC-9.5) OVER 1-3/4" SUPERPAVE SURFACE COURSE - 9.5 (SSC-9.5) OVER

6" HIGH-EARLY-STRENGTH CEMENT CONCRETE BASE COURSE OVER BASE:

SUBBASE: 8" GRAVEL BORROW (M1.03.0 TYPE B)

#### FULL DEPTH HOT MIX ASPHALT RAILROAD GRADE CROSSING

SURFACE COURSE: 2" SUPERPAVE SURFACE COURSE - 9.5 (SSC-9.5) OVER

INTERMEDIATE COURSE: 6" SUPERPAVE INTERMEDIATE COURSE - 19.0 (SIC-19.0)

PLACED IN TWO 3" LIFTS OVER

FOUNDATION: **EXISTING BALLAST** 

# PAVEMENT MICROMILLING & RESURFACING

### (MAIN ST. & COMM. AVE.)

SURFACE COURSE: 1-3/4" SUPERPAVE SURFACE COURSE - 9.5 (SSC-9.5)

**SURFACE MILLING:** 1-3/4" PAVEMENT MICRO-MILLING TO MATCH EXISTING CROSS SLOPE

# STONE DUST SHOULDER

SURFACE: 4" STONE DUST (SPECIAL PROVISION ITEM 704.2) OVER

GEOTEXTILE FABRIC FOR SEPARATION OVER

FOUNDATION: 2" - 8" GRAVEL BORROW (M1.03.0 TYPE B) (SEE NOTE UNDER FULL DEPTH HOT MIX ASPHALT SHARED USE PATH)

#### CEMENT CONCRETE SIDEWALKS, REST AREAS & WHEELCHAIR RAMPS:

SURFACE COURSE: 4" CEMENT CONCRETE (AIR ENTRAINED 4000 PSI, 3/4", 610) OVER

SUBBASE: 8" GRAVEL BORROW (M1.03.0 TYPE B)

#### PROPOSED CEMENT CONCRETE SIDEWALK AT DRIVEWAYS

6" CEMENT CONCRETE (AIR ENTRAINED 4000 PSI, 3/4", 610) OVER SURFACE:

FOUNDATION: 8" GRAVEL BORROW (TYPE B)

#### COBBLE STONE SPLITTER ISLANDS:

SURFACE COURSE: 4" COBBLE STONE OVER

SUBBASE: 4" CEMENT CONCRETE (AIR ENTRAINED 4000 PSI, 3/4", 610)

#### HOT MIX ASPHALT SIDEWALKS

SURFACE: 1" SUPERPAVE SURFACE COURSE - 9.5 (SSC-9.5) OVER 1-1/2" SUPERPAVE INTERMEDIATE COURSE 12.5 (SIC-12.5) OVER

SUBBASE: 8" GRAVEL BORROW (M1.03.0 TYPE B OR EXISTING GRAVEL BORROW TO REMAIN)

#### HOT MIX ASPHALT DRIVEWAYS

SURFACE COURSE: 1-1/2" SUPERPAVE SURFACE COURSE 9.5 (SSC-9.5) OVER

INTERMEDIATE COURSE: 2" SUPERPAVE INTERMEDIATE COURSE 12.5 (SIC-12.5) OVER

8" GRAVEL BORROW (M1.03.0 TYPE B) FOUNDATION:

#### FULL DEPTH HOT MIX ASPHALT PARKING LOTS

SURFACE COURSE: 1-1/2" SUPERPAVE SURFACE COURSE 12.5 (SSC-12.5) OVER

INTERMEDIATE COURSE: 2-1/2" SUPERPAVE INTERMEDIATE COURSE 19.0 (SIC-19.0) OVER

8" GRAVEL BORROW (M1.03.0 TYPE B) FOR LEVELING FOUNDATION:

#### PERVIOUS PAVERS

SURFACE COURSE: POROUS PAVER (SPECIAL PROVISION ITEM 708.35) OVER

**FOUNDATION:** 2" DOUBLE WASHED 1/4" LEVELING STONE OVER

4" DOUBLE WASHED 3/4" STONE OVER

18" DOUBLE WASHED 1" TO 1-1/2" CRUSHED STONE OVER

SUBBASE: GRAVEL BORROW (M1.03.0 TYPE B) AS REQUIRED

# TACK COAT

ASPHALT EMULSION FOR TACK COAT (RS-1H) SHALL BE APPLIED PRIOR TO PAVING HMA OVERLAYS TO BOND LAYERS FOR FLEXURAL STRENGTH. HMA JOINT SEALANT SHALL BE APPLIED TO ALL JOINTS PRIOR TO PAVING THE SURFACE COURSE.

ASPHALT EMULSION FOR TACK COAT (RS-1H) SHALL BE APPLIED AT THE RATE OF 0.07 GAL/S.Y. FOR MILLED SURFACES AND 0.05 GAL/S.Y. FOR SMOOTH TIGHT PAVED SURFACES.

27+40 to 62+40; 62+60 to 68+30: 68+50 to 94+40; 94+60 to 136+40; 136+60 to END 62+50; 68+40; 94+50; 62+50; 68+40; 94+50; 0.00% 0.00% 136+50; 159+85 136+50; 159+85 27+40 to 62+40; 62+60 to 68+30; 68+50 to 94+40; 94+60 to 136+40; 136+60 to END

SHARED USE PATH SLOPING

# HOR. SCALE IN FEET VER. SCALE IN FEET

1(MAX.) PROP. 4" COMPOST TOPSOIL & SEED (TYP.)

PROP. TIMBER RAIL FENCE

FOR LOCATIONS)

2.00' OFFSET FROM PATH EDGE (TYP.)

(SEE CONSTRUCTION PLANS —

PROP. STONE DUST SHOULDER (TYP.)

DUST SHOULDER

(SEE SHEET 6 FOR SUPERELEVATION TABLE)

(TYP.)

PATH SLOPE VARIES

PATH SLOPE VARIES (SEE SHEET 10 FOR SUPERELEVATION TABLE)

☐ REM. EXIST. RAILS & TIES

10.00' PATH

CONST

\* ± 0.5% CONSTRUCTION TOLERANCE (SEE DIAGRAM BELOW FOR SLOPE OF PATH)

PROP. FULL DEPTH HOT MIX


ASPHALT SHARED USE PATH

PROP. FULL DEPTH HOT MIX

ASPHALT SHARED USE PATH

FILL SECTION

PATH SLOPE VARIES (SEE THIS SHEET FOR SHARED USE PATH SLOPING DIAGRAM)

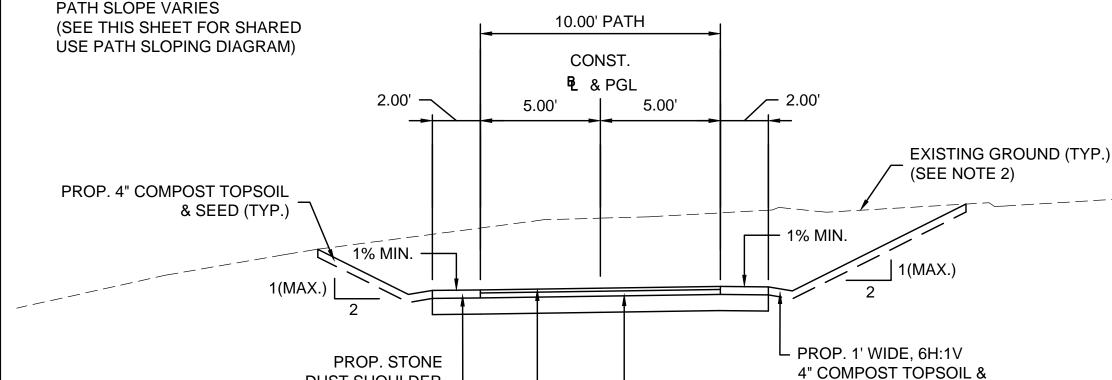

**CUT SECTION** 

\* ± 0.5% CONSTRUCTION TOLERANCE (SEE DIAGRAM BELOW FOR SLOPE OF PATH)

SEED SWALE\*\* (TYP.)

\*\*SWALES LONGER THAN 500' SHALL UTILIZE A 3' WIDTH OF MATTING FOR EROSION CONTROL FOR ENTIRE LENGTH (ITEM 767.9) (STA. 27+40-30+00 RT, 24+25-31+84 LT, 62+50-67+90 LT. 95+95-102+50 LT, 96+03-101+77 RT, 144+74-150+74 LT, 149+99-156+49 RT)

EXISTING GROUND (TYP.)

(SEE NOTE 2)

# TYPICAL SECTION - 10' WIDE PATH


SCALE 1" = 4' STA. 27+40± - STA. 28+54± STA. 29+23± - STA. 75+79± STA. 76+22± - STA. 103+31± STA. 103+69± - STA. 116+13± STA. 117+66± - STA. 124+27± STA. 140+41± - STA. 159+71± STA. 160+04± - STA. 163+80±

(SEE NOTE 1)

# NOTES:

1. THE SECTIONS OF PROPOSED ROADWAY NOT COVERED IN THE RANGE OF STATIONS ASSOCIATED WITH THE TYPICAL SECTIONS ARE EITHER IN TRANSITION OR ARE LOCATED AT INTERSECTIONS AND THEREFORE HAVE NOT BEEN SHOWN. REFER TO CROSS SECTION SHEETS FOR MORE DETAILS.


2. CONTRACTOR SHALL REMOVE EXISTING ORGANIC MATERIAL (ABOVE RAILROAD BALLAST) THAT IS UNSUITABLE FOR REUSE AND DISPOSE OF OUTSIDE OF THE PROJECT LIMITS. IT IS ASSUMED THAT ALL OTHER EXCAVATED SUITABLE MATERIAL WILL REMAIN WITHIN THE PROJECT LIMITS. SEE SPECIAL PROVISIONS FOR DETAILS.

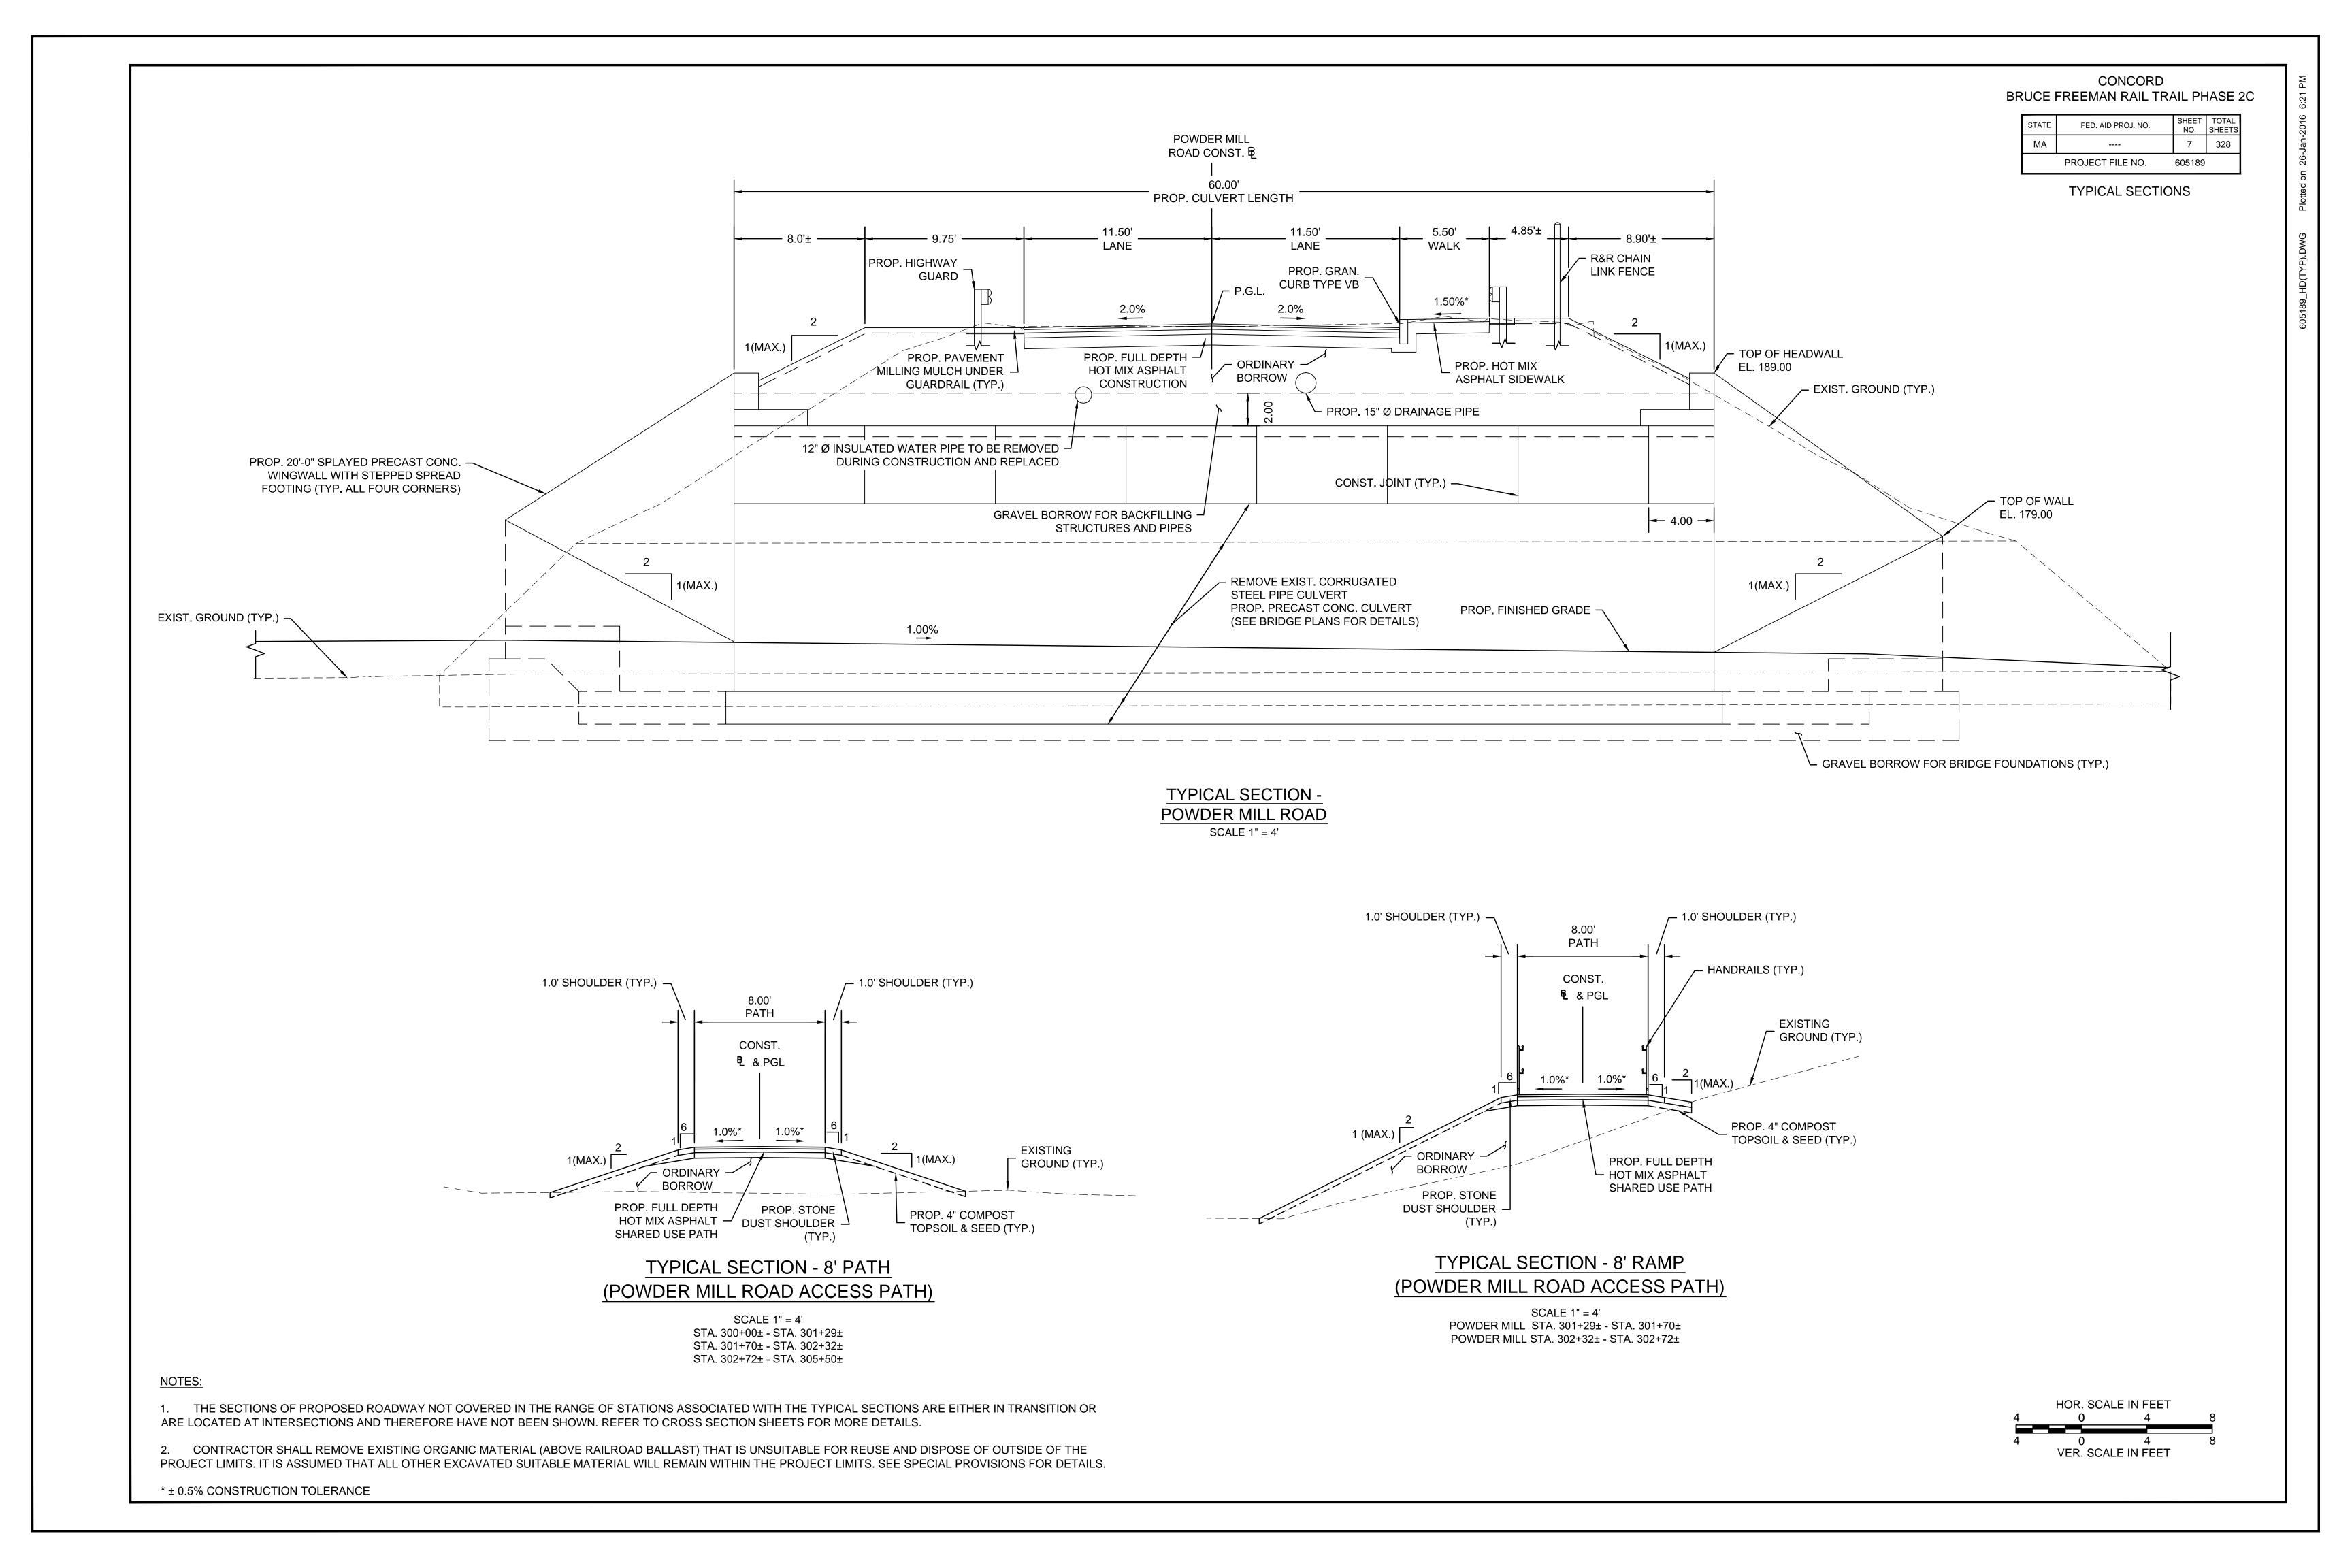

CONCORD BRUCE FREEMAN RAIL TRAIL PHASE 2C


STATE	FED. AID PROJ. NO.	SHEET NO.	TOTAL SHEETS
MA		8	328
	PROJECT FILE NO.	605189	

TYPICAL SECTIONS

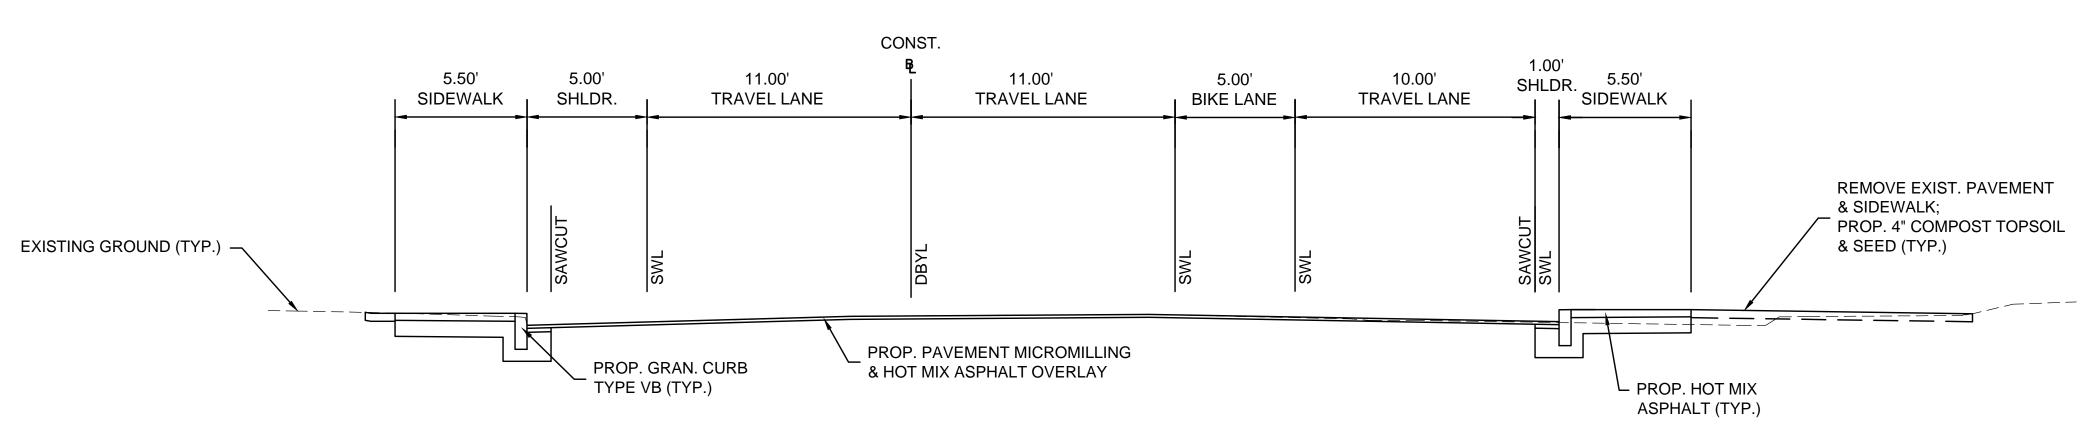

# TYPICAL SECTION MAIN STREET SCALE 1" = 4'

MAIN STREET STA. 700+47± TO STA. 704+46±

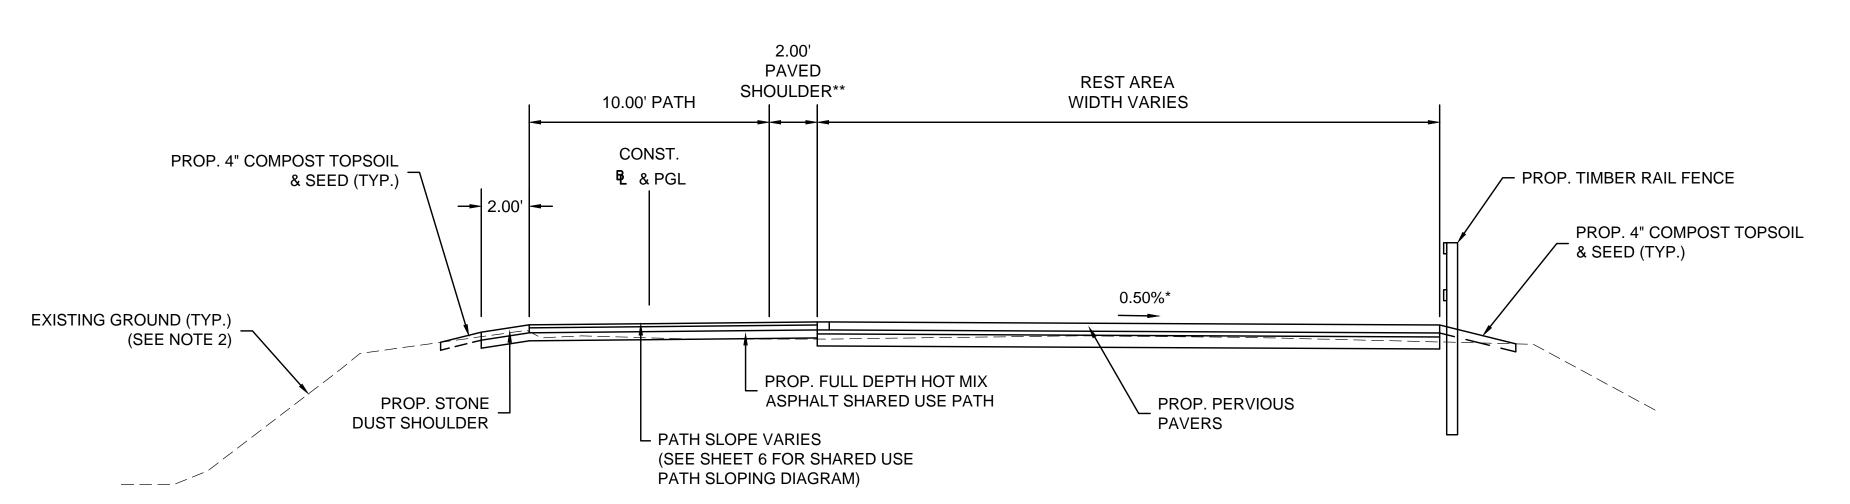

\*\*NO PAVED SHOULDER BETWEEN THE PATH AND REST AREA FROM STA. 117+18± TO STA. 117+65±

## TYPICAL SECTION - 10' WIDE PATH WITH


PERVIOUS PAVER REST AREA

SCALE 1" = 4'
STA. 117+18± TO 117+65±
STA. 138+41± TO 139+00±
STA. 139+60± TO 140+45 ±

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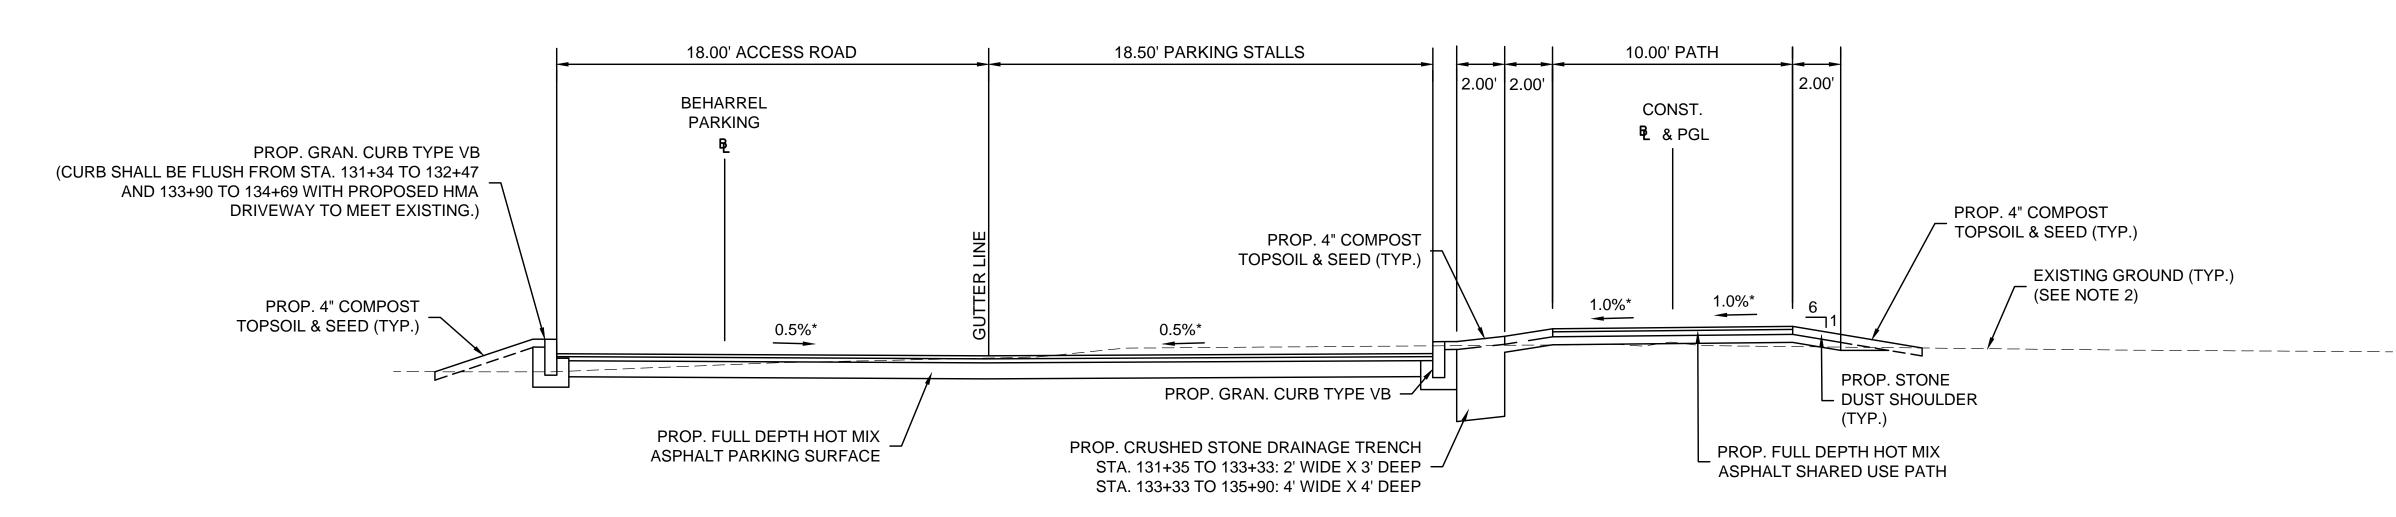
\* ± 0.5% CONSTRUCTION TOLERANCE



CONCORD BRUCE FREEMAN RAIL TRAIL PHASE 2C
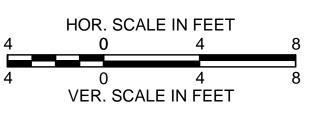
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TYPICAL SECTIONS




TYPICAL SECTION - 10' WIDE PATH AT

BEHARRELL STREET PARKING


SCALE 1" = 4'

STA. 131+19± - STA.136+39±

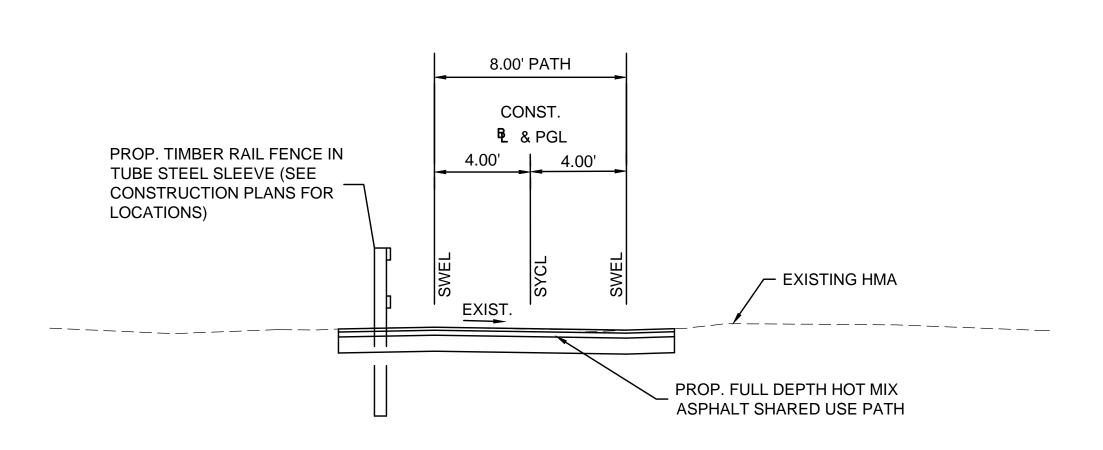

TYPICAL SECTION - 8' WIDE PATH
THROUGH WEST CONCORD CENTER

SCALE 1" = 4' STA. 126+67± - STA. 129+48±

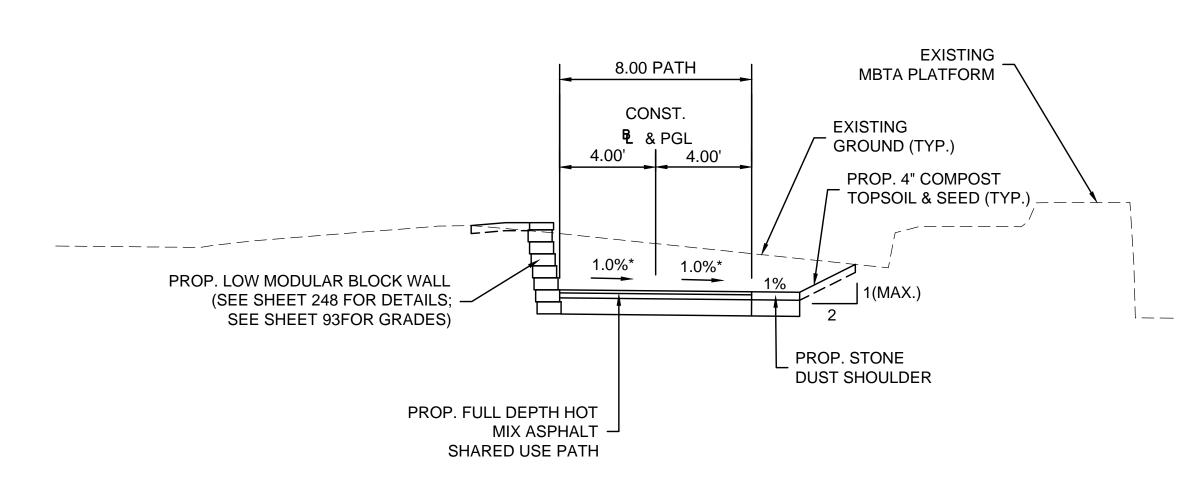


TYPICAL SECTION - 8' WIDE PATH
CUT SECTION WITH LOW RETAINING WALL

SCALE 1" = 4' STA. 129+48± - STA. 129+96±

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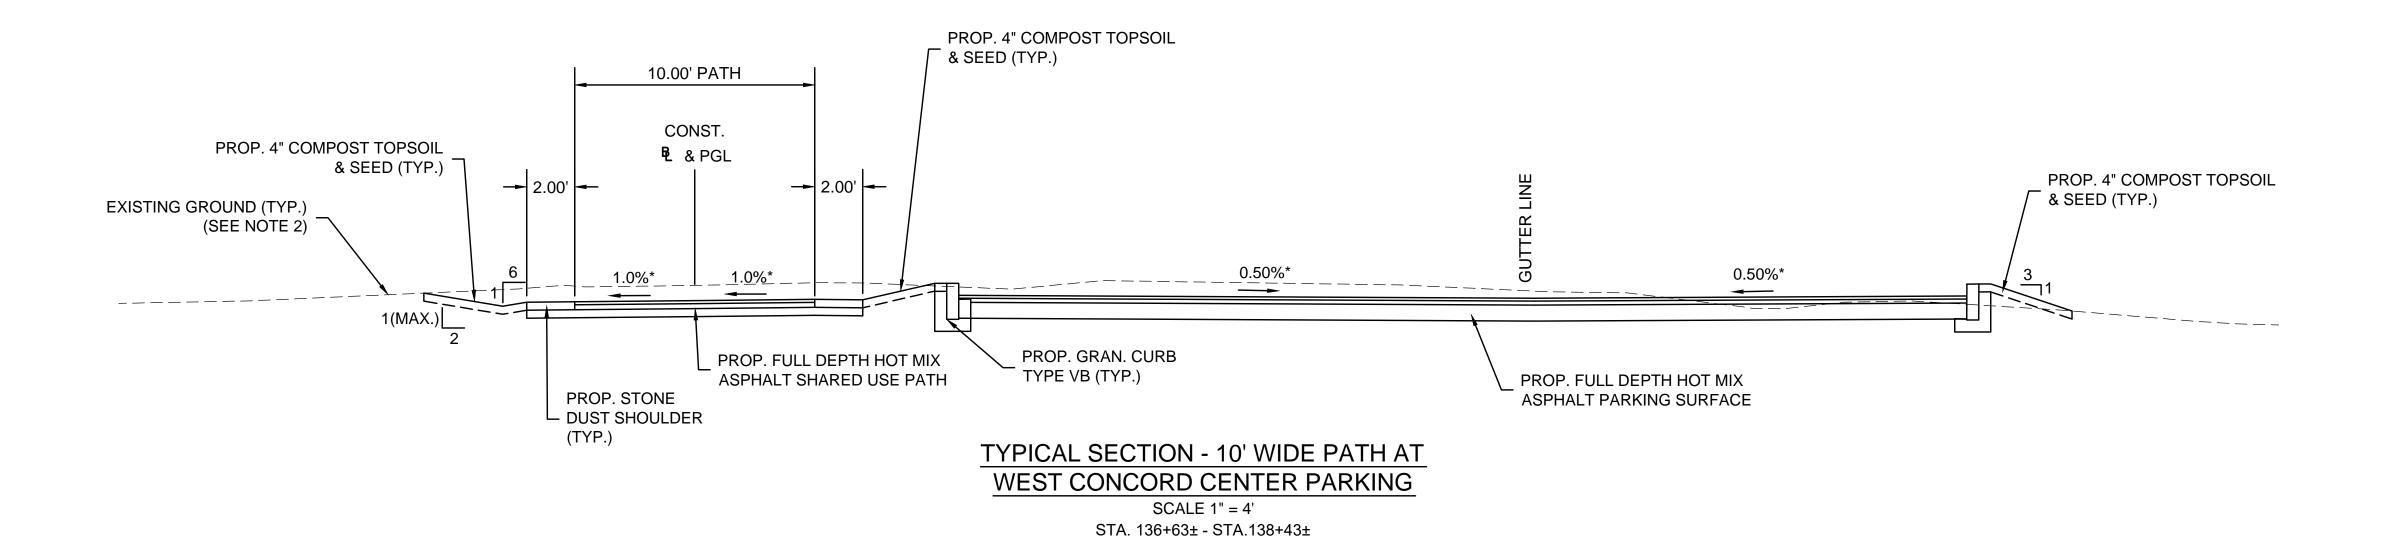
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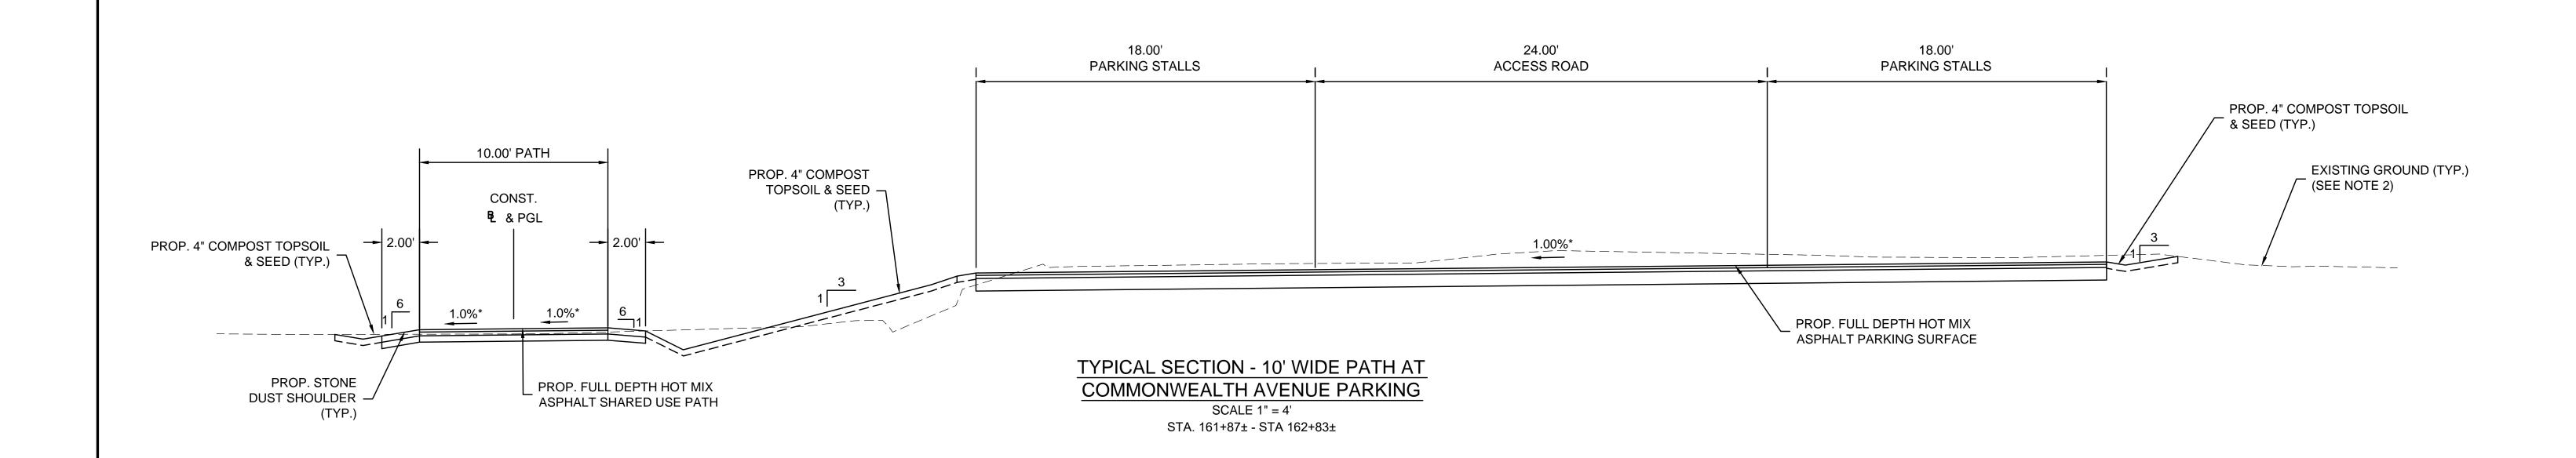


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TYPICAL SECTIONS



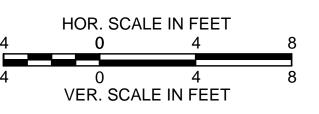

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